Our Reference: 9327470



4 September 2023

Dongwei Zhang Beveridge Williams 1 Glenferrie Road Malvern Vic 3144

Dear Dongwei

## PA2014/4497 - Davis Vineyard Estate Precinct 2 - Stage 8 - Engineering Plans - Approval Letter

The above-mentioned plans, received by Council on and complied on 1 September 2023, are approved. Please find attached the approved stamped road & drainage plans.

Council believes the list below represents the latest plan submission:

#### Project No: 1600029

#### Drawing #

Revision #

001 to 002, 010 to 011, 100 to 101, 200 to 201 300, 350 and 400 to 401

The approval is subject to compliance of all statutory and legal obligations and granted with the understanding that the engineering consultant, developer and landowner take full responsibility for the design contained in the approved engineering plans.

### Please note the following:

- The approval of these plans is valid for one year. Where construction does not commence within that time, the plans must be resubmitted to Council for assessment using applicable engineering standards at the time of resubmission. New plan checking fees will also be applicable.
- No construction works can commence outside the development's property boundaries unless or until consent is provided by the adjoining landowner.
- A 'Consent to Work Within a Road Reserve' must be applied for where works will be done on an existing road. The form is available on Melton Council's website link <a href="https://www.melton.vic.gov.au/Services/Building-Planning-Transport/Engineering/Engineering-applications">https://www.melton.vic.gov.au/Services/Building-Planning-Transport/Engineering/Engineering-applications</a>
- A Traffic Management Plan must be submitted where works will occur on existing roads, and where the works are traffic impact works, it must be approved by Council's Traffic team before works commence. The form is available on Melton Council's website link <u>https://www.melton.vic.gov.au/Services/Building-Planning-Transport/Engineering/Engineering-applications</u>

A thriving community where everyone belongs

**Civic Centre** 232 High Street Melton VIC 3337 Postal Address PO Box 21 Melton VIC 3337

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🕲 melton.vic.gov.au

f cityofmelton

# DAVIS VINEYARD PRECINCT 2 - STAGE 8 AUSTRALIAN INVESTMENT & DEVELOPMENT PTY. LTD. CITY OF MELTON

#### CONSTRUCTION NOTES

#### SITE MANAGEMENT

- A1. Prior to commencement of works on site, the contractor must ensure that all matters relating to the Occupational Health & Safety Act 2004, including all relevant regulations, have been addressed. In particular, the required notifications must be conveyed to the Victorian Workcover Authority - Health & Safety division with respect to trenching operations. Details of the contractors occupational health & safety procedures must be lodged with the superintendent prior to commencement of works.
- A2. All native trees & shrubs to be retained unless road construction necessitates their removal or removal is directed by the engineer A town planning permit is required for the removal of native trees & / or vegetation. The removal or retention of any existing trees must be in accordance with the approved landscape plan, or else approval will be required from the City of Melton landscape approvals officer.
- A3. Existing dam or watercourses to be excavated to a firm base & backfilled as specified. Consulting engineer to be notified when the dam or watercourses are excavated to a firm base. No filling is to be careful on the dam or backfilled as the set of the set o
- A4. Prior to commencement of works, the contractor must submit a Site Management Plan (SMP) to the consultant for approval. The contractor must comply with the recommendations of the Environment Protection Authority publication No.275 "Construction techniques for sediment pollution control". Appropriate siltation control is to be maintained throughout the construction & maintenance period of the works.
- A5. Provide temporary safety barrier fence (Farm Fence as per MW Std Dwg 7251/4/203) along extent of outfall drain where the drain is greater than 1.5m in depth & side slopes are steeper than 1 in 3. Safety fence to remain until permanent underground drainage is installed.
- A6. A temporary fence shall be erected & maintained around existing trees, nominated to be retained, at all times during construction
- A7. Contractor to remove existing irrigation & drainage pipes & pits encountered on site. Trenches to be backfilled in accordance with notes C2 & C3.
- A8. Contractor is obliged to obtain a permit for any blasting works. The contractor when engaged in blasting operation, shall not blast with 4.50m of an existing line of water, gas or sewer pipes or with 15m of any completed part of the works without the consent of the superintendent.
- A9. Contractor is obliged to obtain the necessary "works within road reserve" consent from the relevant authority for works encroaching onto an established road reserve.
- A10. Contractor need a traffic management plan approved by Council for all traffic impacting works.

#### GENERAL

- B1. All works to be carried out to the standard of drawings and specifications as approved by Melton City Council. In case of dispute the Specifications must take precedence.
- B2. Pre-commencement meeting needs to be scheduled with Council prior to commencement of works.
- B3. Before commencement of works on trenches in excess of 1.5m deep, the civil contractors construction supervisor must give notice in writing of such proposals to Worksafe Victoria in accordance with Part 5.1, Division 4 of the Occupational Health & Safety regulations (2007) & undertake safety pre-cutions in trenching operations in accordance with Workcover's code of practice (1988).
- B4. Lots to be graded (1 in 150 min slope) & left clean to the satisfaction of the engineer. Finished levels to be compatible with lots adjoining this stage.
- B5. On completion the contractor is responsible for the removal of all rubbish & spoil from site. No surplus trees, vegetation or other material is to be burnt on site.
- B6. Reserves to be free draining & to be left in a condition satisfactory to the City of Melton works supervisor
- B7. Where works are in the vicinity of existing services these services are to be located & the various authorities notified prior to the commencement of works.
- B8. All TBM's & control points are to be maintained & protected at all times during construction. Should any marks be disturbed, the contractor will immediately notify the consultant to arrange re-instatement at the contractors expense.
- B9. Provide painted paling fence along any boundary common to lots & municipal reserves. Timber railings need to be facing inwards to the property side.
- B10. All nature strips & excavated or filled areas outside of the road reserves shall be surfaced with a 100mm compacted layer of topsoil as specified.
- B11. All line-marking to be long-life thermoplastic line-marking.

#### ROADWORKS

- C1. 100e agricultural pipe drains (Council Std. Dwg. MCC 202) to be placed behind all kerb & channel & buffer pitchers & where directed by the engineer.
- C2. Filling in all properties & road reserves is to be carried out using approved clay fill. Top soil & all vegetable matter to be stripped from site prior to filling. All filling to be carried out in accordance with AS3788-2007 and the geotechnical report. Level 1 inspection and testing to be carried out in accordance with AS3788-2007 section 8.2. A fill report must be submitted to the Consultant, showing from a NATA registered soil testing laboratory.
- C3. Importing Fill: All imported fill must be tested by a NATA approved laboratory to ensure it is suitable for use on site, & any contaminates are within accepted levels. Under no aircumstances should fill material enter or leave the site without the permission of the supervising engineer & Council works supervisor, prior to it being appropriately tested. All vehicles transporting fill material to & from the site must have appropriate measures in place to ensure that material does not get onto roads & into stormwater systems & natural waterways.

- C4. Batters to be 1 in 5 for fill & 1 in 3 for cut unless noted otherwise.
- C5. Cut batters are to be grassed & mulched with a mixture of chopped grass, straw & bitumen emulsion.
- C6. Where cut batters exceed 700mm an additional 300mm berm shall be formed behind footpath.
- C7. Access ramps are to be constructed where cut batters exceed 1.0m. They are to be graded 1 in 10 for the first 2.5m from the back of path & then at a maximum of 1 in 4 to natural surface.
- C8. The water conduit offset from the lot boundary is given on the water reticulation plan. The contractor must construct conduits to accord with the given offset & ensure that the concreter marks the kerb & footpath exactly above the conduit.
  C9. Imigation conduits are to be DN100 DWV PVC installed beneath the pavement and/or capping layer, if present. Locations are to
- be marked using a green dot spray painted on the top of kerb.
- C10. All footpaths are to be 125mm thick 25MPa concrete with SL72 mesh centrally located in accordance with the MPA standard drawing EDCM 401.
- C11. NBN Co to be notified seven (7) days prior to concrete works being placed.
- C12. Electrical distribution pits within footpaths are to be a minimum of 300mm within the edge of the path. Concrete is to be placed around distribution pits to a minimum depth of 200mm.
- C13. All street signs to be constructed & erected to current City of Melton standards including logo. Street signs to be erected as per Council Std. Dwg.MCC 205.
- C14. Traffic control signs, markings & delineators to be installed in accordance with AS1742.2. All line marking is to be long life road marking, with longitudinal lines in thermoplastic & transverse markings in cold applied.
- C15. Driveways to be constructed in accordance with the Council Std. Dwg. MCC 501-503. Single driveways to be a minimum 3.5m wide & to be offset 0.60m from property boundary unless otherwise shown.
- C16. Kerb transition to take place in the minor street over a 2.0m length from either the tangent point or TP pit.
- C17. Existing road works to be reconstructed as required to provide, without discontinuity, a connection in accordance with design levels & oracles.
- C18. Tactile ground surface indicators (TGSI) are to be installed at all pram crossings & pedestrian cross points in accordance with AS1428.4 : 2002 & MPA standard drawing EDCM 403.

#### DRAINAGE

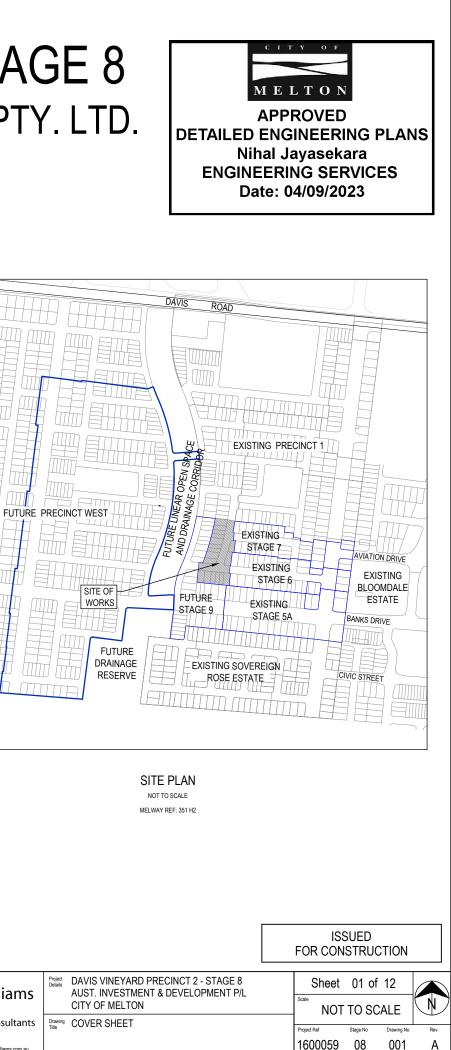
- D1. Drainage & pits to be set out from offsets shown rather than from centreline pipe chainages.
- D2. Lightweight fibreglass type pit lids are required for all drainage pits & all grates for pits are to be Class D, to comply with AS3996 unless otherwise shown. All drainage works are to be constructed to council specifications.
- D3. All pipes up to and including 750mm in diameter shall be rubber ring jointed (RRJ). Pipes above this size may be flush jointed with external sealing bands. For pipes greater than 900mm and changes in direction between 2 connecting pipes exceeding 10° construct segmented curves using splayed pipes with bander go joints, and within the manufacturer's specification.
- D4. All pipes to be Class '2' R.C. rubber ring joint unless noted otherwise. PVC pipes to be Class SH unless specified.
- D5. Pipe trenches beneath the road pavement, footpath or within 150mm of the kerb & channel to be backfilled with 20mm Class 3 FCR in 150mm layers.
- D6. Property inlets to be constructed as per MPA standard drawing EDCM 701 EDCM 704.
- D7. All proposed drainage stubs to be blanked off at end of pipe with timber planks to the satisfaction of the supervising engine

#### PAVEMENT

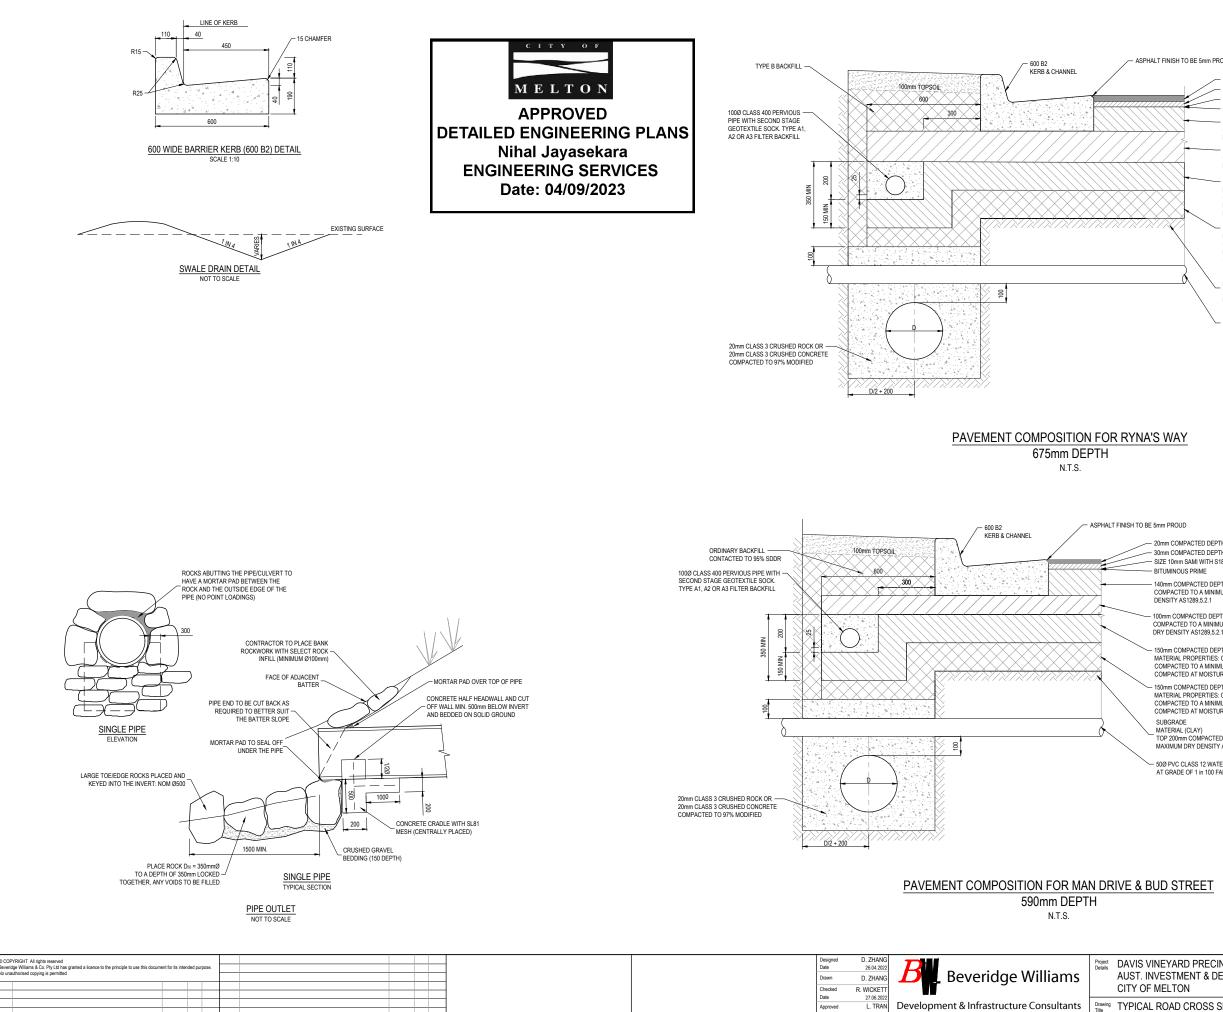
E1. Modification of the pavement requires approval by the City of Melton works supervisor.

#### DRAWING INDEX

DRAWING No.	TITLE	REV
1600059-08-001	COVER SHEET	A
1600059-08-002	TYPICAL ROAD CROSS SECTIONS AND PAVEMENT MAKEUP & GENERAL ETAILS	A
1600059-08-010	LAYOUT PLAN	A
1600059-08-011	INTEGRATED WATER MANAGEMENT PLAN	Α
1600059-08-100	ROAD LONGITUDINAL SECTION - RYNA'S WAY	Α
1600059-08-101	ROAD LONGITUDINAL SECTION - MAN DRIVE	A
1600059-08-200	ROAD CROSS SECTIONS - RYNA'S WAY	Α
1600059-08-201	ROAD CROSS SECTIONS - MAN DRIVE	A
1600059-08-300	INTERSECTION DETAILS	Α
1600059-08-350	SIGNAGE & LINE MARKING PLANS	A
1600059-08-400	DRAINAGE LONGITUDINAL SECTIONS (SHEET 1 OF 2)	Α
1600059-08-401	DRAINAGE LONGITUDINAL SECTIONS (SHEET 2 OF 2) & PIT SCHEDULE	Α



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Α	A ISSUED FOR CONSTRUCTION	01.09.23	D.Z.	S.M.					
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01.09.23 D.Z. S.M

DATE DRN. APP.

REV

DESCRIPTION

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A ISSUED FOR CONSTRUCTION

DESCRIPTION

n PROUD
30mm COMPACTED DEPTH OF 10mm NOM. SIZE TYPE N CLASS 320 ASPHALT  30mm COMPACTED DEPTH OF 10mm NOM. SIZE TYPE N CLASS 320 ASPHALT  SIZE 10mm SAMI WITH S18RF BINDER  BITUMINOUS PRIME
— 130mm COMPACTED DEPTH OF 20mm NOM. SIZE CLASS 2 CRUSHED ROCK COMPACTED TO A MINIMUM MEAN DENSITY RATIO OF 100% (CHARACTERISTIC MODIFIED) MAXIMUM DRY DENSITY AS1289,5.2.1
— 185mm COMPACTED DEPTH OF 20mm NOM. SIZE CLASS 3 CRUSHED ROCK COMPACTED TO A MINIMUM MEAN DENSITY RATIO OF 98% (CHARACTERISTIC MODIFIED) MAXIMUM DRY DENSITY AS1289,5.2.1
— 150mm COMPACTED DEPTH OF TYPE A MATERIAL (CAPPING LAYER) MEETING THE FOLLOWING MATERIAL PROPERTIES: CBR ≥8%, SWELL ≤1.5%, PERMEABILITY K ≤ 1 x 10 <sup>9</sup> m/s (1 x 10 <sup>7</sup> cm/s) COMPACTED TO A MINIMUM MEAN DENSITY RATIO OF 100% (STANDARD) MAXIMUM DRY DENSITY S31299.5.1., COMPACTED AT MOISTURE CONTENT OF ±2.0% OF STANDARD OPTIMUM MOISTURE CONTENT.
→ 150mm COMPACTED DEPTH OF TYPE A MATERIAL (CAPPING LAYER) MEETING THE FOLLOWING MATERIAL PROPERTIES: CBR 88%, SWELL \$1.5%, PERMEABILITY K ≤ 1 x 10 <sup>9</sup> m(s) (1 x 10 <sup>7</sup> cm/s) COMPACTED TO A MINIMUM MEAN DENSITY RATIO OF 100% (STANDARD) MAXIMUM DRY DENSITY AS1289,5.1.1, COMPACTED AT MOISTURE CONTENT OF ±2.0% OF STANDARD OPTIMUM MOISTURE CONTENT.
SUBGRADE MATERIAL (CLAY) TOP 200mm COMPACTED TO A MINIMUM DENSITY RATIO OF 98% (STANDARD) MAXIMUM DRY DENSITY AS1289,5.1.1
500 PVC CLASS 12 WATER CONDUIT & 500 PVC CLASS 12 GAS CONDUITS LAID AT GRADE OF 1 in 100 FALLING TOWARDS LOW SIDE OF STREET.

20mm COMPACTED DEPTH OF 7mm NOM, SIZE TYPE L CLASS 320 ASPHALT 30mm COMPACTED DEPTH OF 10mm NOM. SIZE TYPE N CLASS 320 ASPHALT - SIZE 10mm SAMI WITH S18RF BINDER 140mm COMPACTED DEPTH OF 20mm NOM, SIZE CLASS 2 CRUSHED ROCK COMPACTED TO A MINIMUM MEAN DENSITY RATIO OF 100% (CHARACTERISTIC MODIFIED) MAXIMUM DRY DENSITY AS1289,5.2.1 – 100mm COMPACTED DEPTH OF 20mm NOM. SIZE CLASS 4 CRUSHED ROCK COMPACTED TO A MINIMUM MEAN DENSITY RATIO OF 98% (CHARACTERISTIC MODIFIED) MAXIMUM DRY DENSITY AS1289,5.2.1 - 150mm COMPACTED DEPTH OF TYPE A MATERIAL (CAPPING LAYER) MEETING THE FOLLOWING MATERIAL PROPERTIES: CBR =8%, SWELL s1.5%, PERMEABILITY k  $\pm$  1 x  $10^{9}$  mis (1 x  $10^{7}$  cm/s) COMPACTED TO A MINIMUM MEAN DENSITY PATIO GF 100% (STANDARD) MAXIMUM DRY DENSITY AS1289,5.1.1, COMPACTED AT MOISTURE CONTENT OF ±2.0% OF STANDARD OPTIMUM MOISTURE CONTENT. 150mm COMPACTED DEPTH OF TYPE A MATERIAL (CONSTRUCTION LAYER) MEETING THE FOLLOWING MATERIAL PROPERTIES: CBR a8%, SWELL s1.5%, PERMEABILITY k s1 x 10<sup>3</sup> mis (1 x 10<sup>7</sup> cm/s) COMPACTED TO A MINIMUM MEAN DENSITY RATIO OF 100% (STANDARD) MAXIMUM DRY DENSITY AS1289,5.1.1, COMPACTED AT MOISTURE CONTENT OF ±2.0% OF STANDARD OPTIMUM MOISTURE CONTENT. TOP 200mm COMPACTED TO A MINIMUM DENSITY RATIO OF 98% (STANDARD) MAXIMUM DRY DENSITY AS1289,5.1.1 – 500 PVC CLASS 12 WATER CONDUIT & 500 PVC CLASS 12 GAS CONDUITS LAID AT GRADE OF 1 in 100 FALLING TOWARDS LOW SIDE OF STREET.

Development & Infrastructure Consultants

ph: 03 9524 8888 www.beveridgewillia

Approved Reg. No.

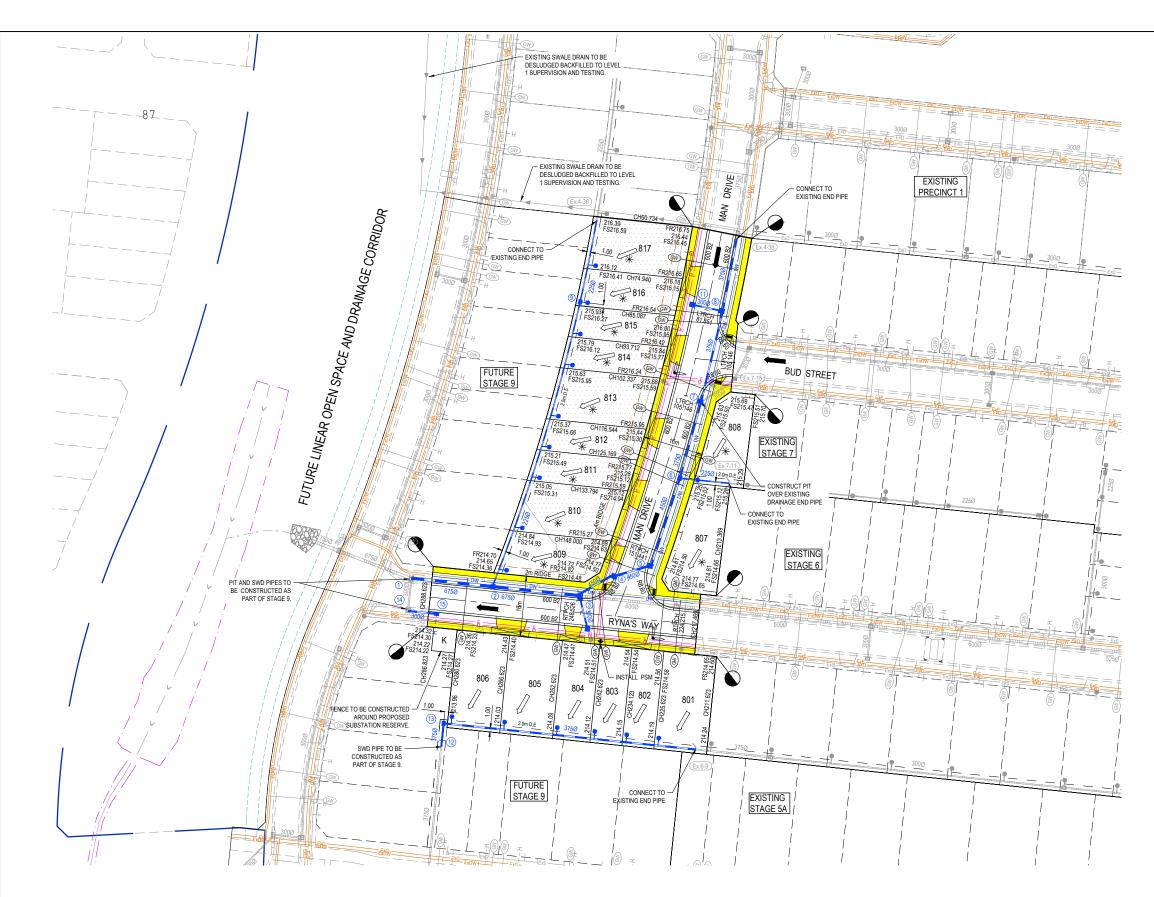
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1 Glenferrie Road Malvern VIC 3144

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Drawing Title	TYPICAL ROAD CROSS SECTIONS AND PAVEMENT MAKEUP & GENERAL DETAIL		Project Ref 1600059	Stage No	Drawing No	Rev A
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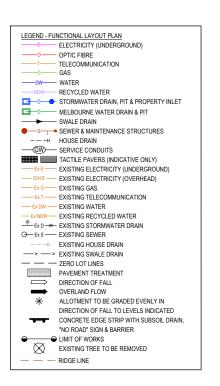
#### SERVICE OFFSET TABLE

	G	as	Wa	ater	Elec	tricity	Telecomr	nunication	Sewer		
Location	Side	Offset (m)	Side	Offset (m)	Side	Offset (m)	Side	Offset (m)	Side	Offset (m)	
RYNA'S WAY	N	2.10	N	2.60	S	2.60	S	1.90	N/S	1.00	
BUD STREET	N	2.10	Ν	2.60	S	2.60	s	1.90	N/S	1.00	
MAN DRIVE	E 2.10		E	2.60	W	2.60	W	1.90	W	1.00	
NOTE: STREET TREES ARE					TUDE OTO	IDC					

ROAD LAYOUT	TABLE									
Road Name	Road Classification	Reserve		Road Width (n	n)	Kerb	Туре	Verge Width (m)		
Road Name	Road Classification	Width (m)	Lip to Lip	Inv to Inv	Back to Back	Nth/West	Sth/East	Nth/West	Sth/East	
RYNA'S WAY	ACCESS STREET 1	16.00	6.40	7.30	7.60	600 B2	600 B2	4.50	4.20	
BUD STREET	ACCESS STREET 1	16.00	6.40	7.30	7.60	600 B2	600 B2	4.50	4.20	
MAN DRIVE	ACCESS STREET 1	16.00	6.40	7.30	7.60	600 B2	600 B2	4.20	4.50	

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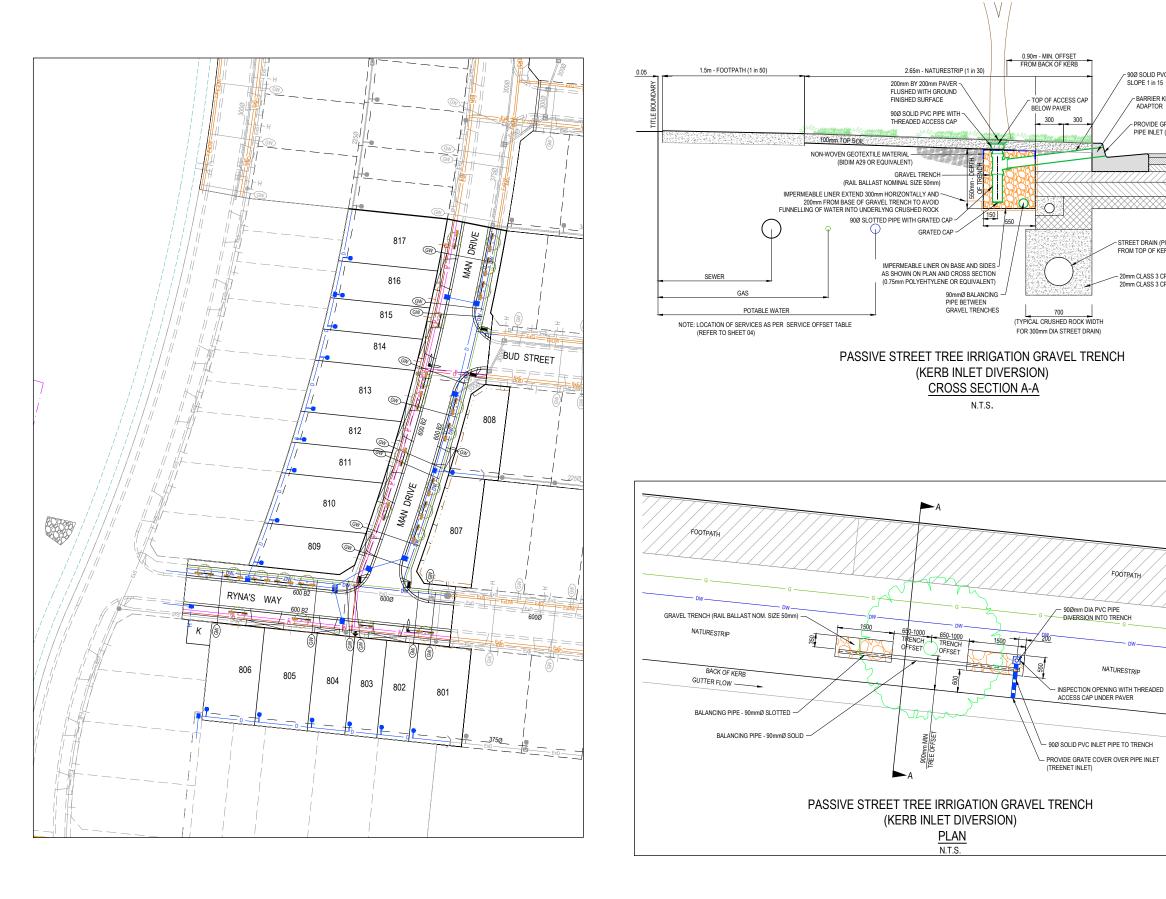


#### NOTES

- ALL SERVICES SHOWN ARE PRELIMINARY AND SUBJECT
- TO AUTHORITY ADVICE & DETAILED DESIGN. EXISTING SERVICES SHOWN ARE INDICATIVE ONLY AND TO BE VERIFIED PRIOR TO DETAILED DESIGN AND
- CONSTRUCTION. ALL EXISTING SERVICES UNDER NEW PAVEMENTS AND CONCRETE WORKS TO BE FCR BACKFILLED, UNLESS
- OTHERWISE SPECIFIED. ALL EXISTING DRAINAGE PITS AND SEWER MH WITHIN NEW WORKS TO BE ADJUSTED TO NEATLY MATCH NEW FINISH SURFACE
- ALL EXISTING OPEN DRAINS WITHIN NEW WORKS TO BE CLEANED, DE-SLUDGED AND BACKFILLED TO LEVEL 1 SUPERVISION.

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NEYARD PRECINCT 2 - STAGE 8 VESTMENT & DEVELOPMENT P/L MELTON	Sheet <sup>Scale</sup> 1:500 @		12	
PLAN	Project Ref	Stage No	Drawing No	Rev
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## 20mm CLASS 3 CRUSHED ROCK OR 20mm CLASS 3 CRUSHED CONCRETE

- STREET DRAIN (PIPE COVER FROM TOP OF KERB 1200mm

PROVIDE GRATE COVER OVER PIPE INLET (TREENET INLET)

~ BARRIER KERB ADAPTOR

~ 90Ø SOLID PVC PIPE.

	1
LEGEND - LA	YOUT PLAN
	STORMWATER DRAIN, PIT & PROPERTY INLET
	SEWER & MAINTENANCE STRUCTURES
	HOUSE DRAIN
$\sim$	SERVICE CONDUITS
	TACTILE PAVERS (INDICATIVE ONLY)
	ELECTRICITY (UNDERGROUND)
O/H E	ELECTRICITY (OVERHEAD)
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	EXISTING ELECTRICITY (UNDERGROUND)
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	EXISTING TELECOMMUNICATIONS
	EXISTING RECYCLED WATER
	EXISTING RECTCLED WATER
	EXISTING SEVER
-	EXISTING BOUSE DRAIN
	EXISTING SWALE DRAIN
	RETAINING WALL
	ZERO LOT LINES
	DIRECTION OF FALL
木	ALLOTMENT TO BE GRADED EVENLY IN
	DIRECTION OF FALL TO LEVELS INDICATED
	CONCRETE EDGE STRIP WITH SUBSOIL DRAIN, "NO ROAD" SIGN & BARRIER
<u> </u>	IMIT OF WORKS
	PERMANENT SURVEY MARK
100 - 100 -	TEMPORARY BENCH MARK
Â	PROPOSED DRIVEWAY
000	PASSIVE STREET TREE IRRIGATION GRAVEL TRENCH
$\odot$	PROPOSED TREE

CITY OF

MELTON

**APPROVED** 

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HORIZONTAL GEOMETRY																			
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DESIGN CENTRELINE	214.696	214.596	214.496	214.438- 214.429-	214.409- 214.396-	214.375- 214.368-		214.325-	214.296- 214.283-	214.253-	214.233-	214.196-	214.163-	214.133-	214.096- 214.093-	214.062- 214.053-	214.023-	213.996- 213.987- 213.987- 213.987- 213.096-	214.050-
	214.589	214.489	214.389	214.331 214.323	214.302 214.289	214.268 214.261		214.219	214.189 214.176	214.147	214.126	214.089	214.056	214.027	213.989 213.986	213.955 213.946	213.916		
EXISTING SURFACE AT RIGHT BOUNDARY					214.795 214.788	214.778 214.778				214.717	214.709	214.692	214.672	214.655	214.618 214.615	214.583 214.573	214.534		
	214.589	214.489	214.389	214.331 214.323	214.302 214.289	214.268 214.261	000	214.219	214.189 214.176	214.147	214.126	214.089	214.056	214.027	213.989 213.986	213.955 213.946	213.916		
EXISTING SURFACE AT LEFT BOUNDARY				214.591	214.581 214.574	214.564 214.560		214.539	214.517 214.506	214.483	214.467	214.446	214.426	214.409	214.364 214.360	214.318 214.306	214.265	214.229	214.078
EXISTING SURFACE	214.799	214.760	214.729	214.700 214.695	214.685 214.679	214.668 214.664		214.643	214.628 214.622	214.605	214.589	214.568	214.548	214.530	214.490 214.486	214.446 214.435	214.396	214.361 214.350 214.350 214.349	214.318 214.315
CHAINAGE	160.000	180.000	200.000	211.623 213.369	217.469 220.000	224.215 225.623		234.123	240.000 242.623	248.526	252.623	260.000	266.623	272.545	280.000 280.623	286.823 288.623	294.670	300.000 301.804 301.890	306.804 310.470
						RTP				RTP									

RYNA'S WAY LONGITUDINAL SECTION

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							-		HORIZ 1:500 0 5 10 20	30	Checked	D. ZHANG R. WICKETT		15
											Date	27.06.2022		
				_			_	_	VERT 1:50 0 0.5 1 2	3	Approved	L. TRAN	Development & Infrastructure Consult	nts Drawing
A	ISSUED FOR CONSTRUCTION	01.09.23	D.Z.	S.M.				-	SCALE AT A1 SIZE		Reg. No. Date	PE0007599 31.08.2023		
REV	DESCRIPTION	DATE	DRN.	APP.	REV DESCRIPTION	DATE	DRN	I. APP			PS Number	PS 822978N/S4	I Gienienie Roau pri. 03 9524 0000	au



LEGEND
EXISTING SURFACE
DESIGN LINE
EXISTING SURFACE AT
RIGHT BOUNDARY
- · - · - · RIGHT LIP OF KERB
EXISTING SURFACE AT
LEFT BOUNDARY
LEFT LIP OF KERB

_		
	ISSUED FOR CONSTRUCTION	
INEYARD PRECINCT 2 - STAGE 8	Sheet 05 of 12	
MELTON	1:500 H 1:50 V @ A1	
ONGITUDINAL SECTION	Project Ref Stage No Drawing No	Rev
WAY	1600059 08 100	A

K:Uobs Data\1600059 Diggers Rest\\_Eng\Precinct 2\Stage 8\Drawings\1600059-08-100-RLS.dwg

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A      ISSUED FOR CONSTRUCTION      01.09.23      D.Z.      S.M.      A        REV      DESCRIPTION      DATE      DRN.      APP.      REV      DESCRIPTION	DATE DRN. APP.	VERT 1:50 0 0.5 1 2 3 Approved L TRA SCALE AT A1 SIZE Reg. No. PE0007 Date 31.08.20 PS Number PS 8229781/3	Development & Infrastructure Consultants 1 Gienferrie Road phr. 03 9524 8888	Drawing Title ROAD LONG MAN DRIVE

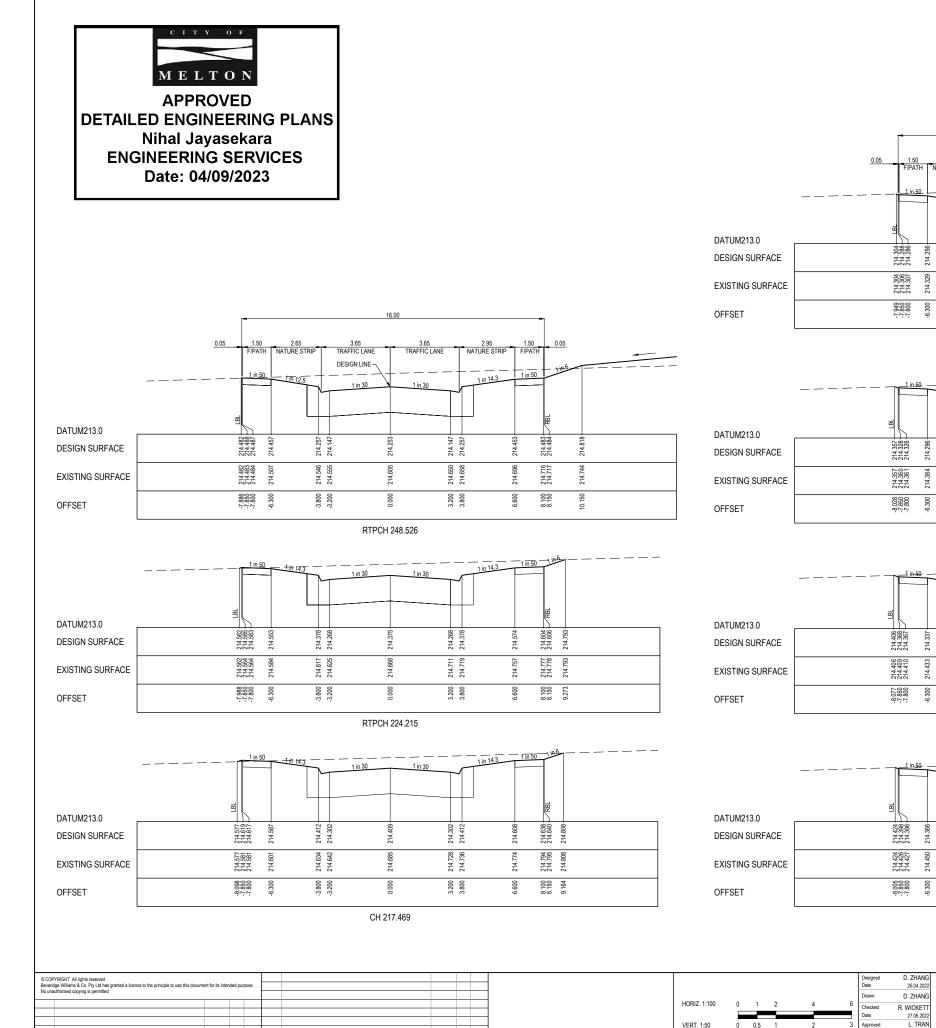
MAN DRIVE LONGITUDINAL SECTION	

	EXISTING STAGE 6 DEVELOPMENT DEVELOPMENT
	INTERSECTION WITH BUD STREET REFER DRAWING 1600059-08-300 FOR DETAILS O DESIGN LINE PROPOSED RIGHT LIP OF KERB
	CH 160 149 EL CT 12 49 20 CH 160 149 CH 160 14
VERTICAL GEOMETRY	-3 % -2.26 % -2.26 % -2.277 %
HORIZONTAL GEOMETRY	R= 540.85m HC
DATUM RL212	
DESIGN CENTRELINE	218.175 217.166 217.166 217.546 217.546 217.546 217.546 215.5466 215.5466 215.5466 215.5466 215.5466 215.54666 215.54666 215.546666666666666666666666666666666
	2117.727 217.467 217.467 217.568 217.568 217.568 216.756 216.756 216.568 216.568 216.568 216.568 216.568 215.500 215.679 215.745 215.750 215.750 215.679 215.745 215.755 215.755 215.755 215.7555 215.75555 215.755555555555555555555555555555555555
EXISTING SURFACE AT RIGHT BOUNDARY	216.443 216.044 216.044 215.6024 215.6024 215.627 215.627 215.545 215.215 215.
	217.647 217.648 217.5648 217.5648 217.5648 217.5648 217.5648 216.7058 216.7058 216.7058 216.7058 216.7058 216.7058 216.5688 216.5688 216.5688 215.305 215.679 215.667 215.679 215.679 215.745 215.755 215.755 215.755 215.755 215.755 215.7555 215.7555 215.7555 215.75555 215.755555555555555555555555555555555555
EXISTING SURFACE AT LEFT BOUNDARY	216.172 216.172 216.048 215.538 215.538 215.538 215.538 215.538 215.538 215.538 215.538 215.538 215.538 214.8500 214.8500 214.8500 214.8500 214.8500 214.8500 214.8500 214.8500 214.8500 214.8500 214.8500 214.8500 214.85000 214.85000 214.85000 214.85000000000000000000000000000000000000
EXISTING SURFACE	217.571 217.571 217.571 217.571 217.541 217.332 217.332 217.332 217.332 217.332 217.332 216.997 217.332 216.997 217.332 216.692 216.692 216.692 216.692 216.692 216.692 216.692 216.692 216.692 216.692 216.692 216.692 216.692 216.692 216.692 216.692 216.692 216.692 216.692 216.571 216.571 216.571 216.571 216.573 216.692 216.573 217.545 216.573 217.545 216.573 217.545 216.573 216.573 217.545 216.573 217.545 216.573 216.573 217.545 216.573 216.573 217.545 216.573 216.573 217.545 216.573 217.545 216.573 217.555 216.573 217.555 216.573 217.5552 216.573 217.5552 216.573 217.5552 216.5755 216.5755 216.5755 216.5755 216.5755 216.5755 216.5755 217.5555 216.5755 216.5755 216.5755 216.5755 217.5555 216.5755 217.5555 216.5755 217.5555 216.5755 217.55555 217.55555 217.55555 216.5755555 217.555555555555555555555555555555555555
CHAINAGE	0.0000 0.0000 110,779 111,155 220,000 220,1770 220,170 220,170 220,170 220,170 220,170 220,170 220,170 243,457 443,457 443,457 100,0000 80,000 80,000 80,000 81,0000 81,0000 81,0000 81,0000 8



		_
	ISSUED FOR CONSTRUCTION	
NEYARD PRECINCT 2 - STAGE 8 VESTMENT & DEVELOPMENT P/L MELTON	Sheet 06 of 12 State 1:500 H 1:50 V @ A1	
ONGITUDINAL SECTION		
VE	Project Ref Stage No Drawing No Rev 1600059 08 101 A	
	Killete Detel/(000000 Discuss Dest) Factory 000	0.1

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A ISSUED FOR CONSTRUCTION

DESCRIPTION

01.09.23 D.Z. S.M.

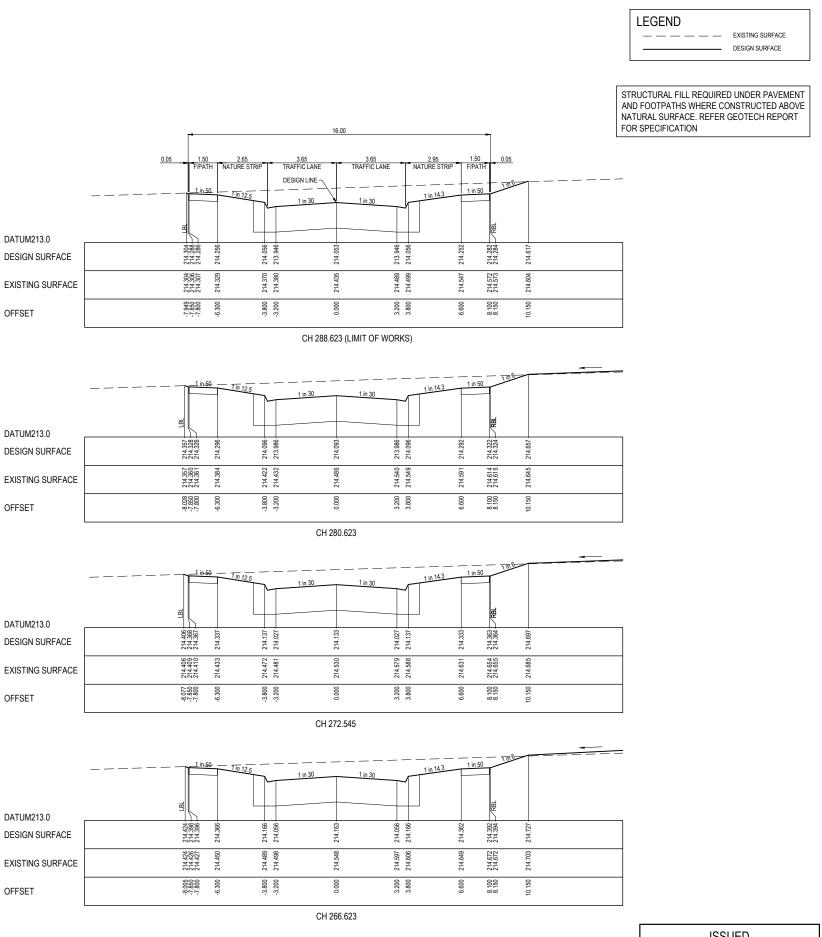
DATE DRN. APP.

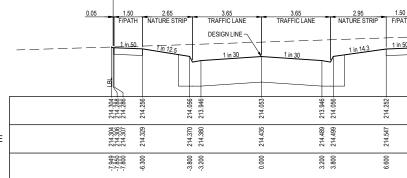
REV

DESCRIPTION

Project DAVIS VIN Beveridge Williams AUST. IN R. WICKETT 27.06.2022 L. TRAN PE0007599 CITY OF Drawing ROAD CR Development & Infrastructure Consultants Approved Reg. No. Date 1 2 SCALE AT A1 SIZE RYNA'S V 31.08.2023 1 Glenferrie Road Malvern VIC 3144 ph: 03 9524 8888 www.beveridgewill DATE DRN. APP. S Number PS 822978N/S4

CH 272.545 1 in 14.3



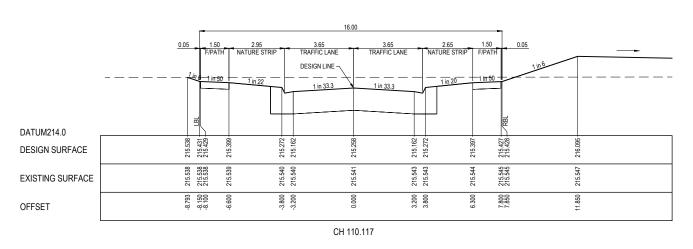


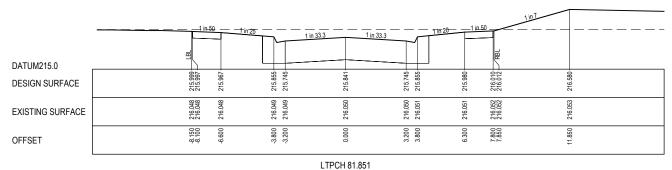
	FOR CONSTRUCTION
INEYARD PRECINCT 2 - STAGE 8	Sheet 07 of 12
MELTON	scale 1:100 H 1:50 V @ A1
ROSS SECTIONS WAY	Project Ref Stage No Drawing No Rev
	1600059 08 200 A

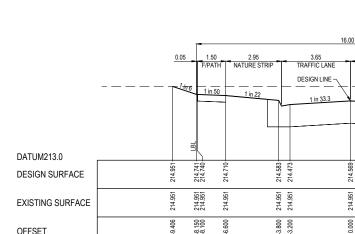
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APPROVED DETAILED ENGINEERING PLANS Nihal Jayasekara **ENGINEERING SERVICES** Date: 04/09/2023



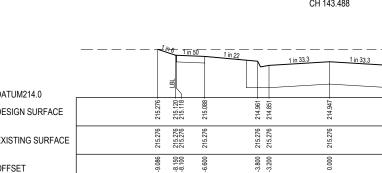




CH 143.488

3.65 2.65 1.50 TRAFFIC LANE NATURE STRIP F/PATH

1 in 33.3



CH 125.169

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VERT. 150  0  0.5  1  2  3  Approved  L TRAN Development & Intrastructure Constitants SCALE AT A1 SiZe  Development & Intrastructure Constitants SCALE AT A1 SiZe  Development & Intrastructure Constitants Table  No. Point A  No. Point SCALE AT A1 SiZe  No. Point SCALE AT A1 SiZe  Development & Intrastructure Constitants Table  No. Point A  No. Point SCALE AT A1 SiZe  Development & Intrastructure Constitants Table  No. Point Table  No. Point A  No. Point SCALE AT A1 SiZe  No. Point A1 SiZe  No. Point A1 SiZe  No. Point A1	COPYRIGHT All rights reserved  Beverdigw Williams & Co. Pty Lib has granted a licence to the principle to use this document for its intended purpose.		HORIZ 1:100 0 1 2 4 6 Checked & KWICKETT & D. ZHANG Checked & Z. YOL 62022	Scale	
	A ISSUED FOR CONSTRUCTION 01.09.23 D.Z. S.M.	DATE DRN. APP.	SCALE AT A1 SIZE Reg. No. PE0007599 Date 31.08.2023 1 Gienferrie Road ph: 03 9524 8888 MAN DRIVE		

DATUM215.0							ľ.		
DESIGN SURFACE	216.142 216.142	216.110	215.998 - 215.888 -	215.984 -	215.888 - 215.998 -	216.123 -	216.153 - 216.155 -	216.655 -	
EXISTING SURFACE	216.172 216.172	216.172	216.173 216.173	216.174	216.174 216.175	216.175	216.175 216.176	216.176	
OFFSET	-8.150 -8.100	-6.600	-3.800	0.000	3.200 3.800	6.300	7.850	11.850	

1 in 33.3

1 in 33.3

216.291 216.181

216.449 216.449

3.800

<u>1 in 50</u>

216.435 216.433

216.451 216.451

-8.150 -8.100 -6.600

16

216.45

DATUM215.0

OFFSET

DESIGN SURFACE

EXISTING SURFACE

CH 74.940	

216.2

216.447

0.000

CH 60.734

216.172 216.172	216.172	216.173 216.173	216.174	216.174 216.175	216.175	216.175 216.176	216.176
-8.150 -8.100	-6.600	-3.200	0.000	3.200	6.300	7.850	11.850

1 in 33.3

1 in 33.3

						RBI
215.998 -	215.888 -	215.984 -	215.888-	215.998 -	216.123 -	216.155 - 216.155 -
216.173	216.173	216.174	216.174	216.175	216.175	216.175 216.176
-3.800	-3.200	0.000	3.200	3.800	6.300	7.850

216.181 216.291

216.445 216.445

3.200 3.800

in 20

0.000	
CH 74 94	10

216	LAISTING
11.850	OFFSET

1 in 10

16

0.850

216.446 216.448

216.443 216.443

7.800 7.850

216.4

216.4

6.300

DATUM214.0		i
DESIGN SURFACE	01E 07E	0/7:017
EXISTING SURFACE	015.076	0/7/017
OFFSET	0 0 0	000.6-

STRUCTURAL FILL REQUIRED UNDER PAVEMENT AND FOOTPATHS WHERE CONSTRUCTED ABOVE NATURAL SURFACE. REFER GEOTECH REPORT FOR SPECIFICATION

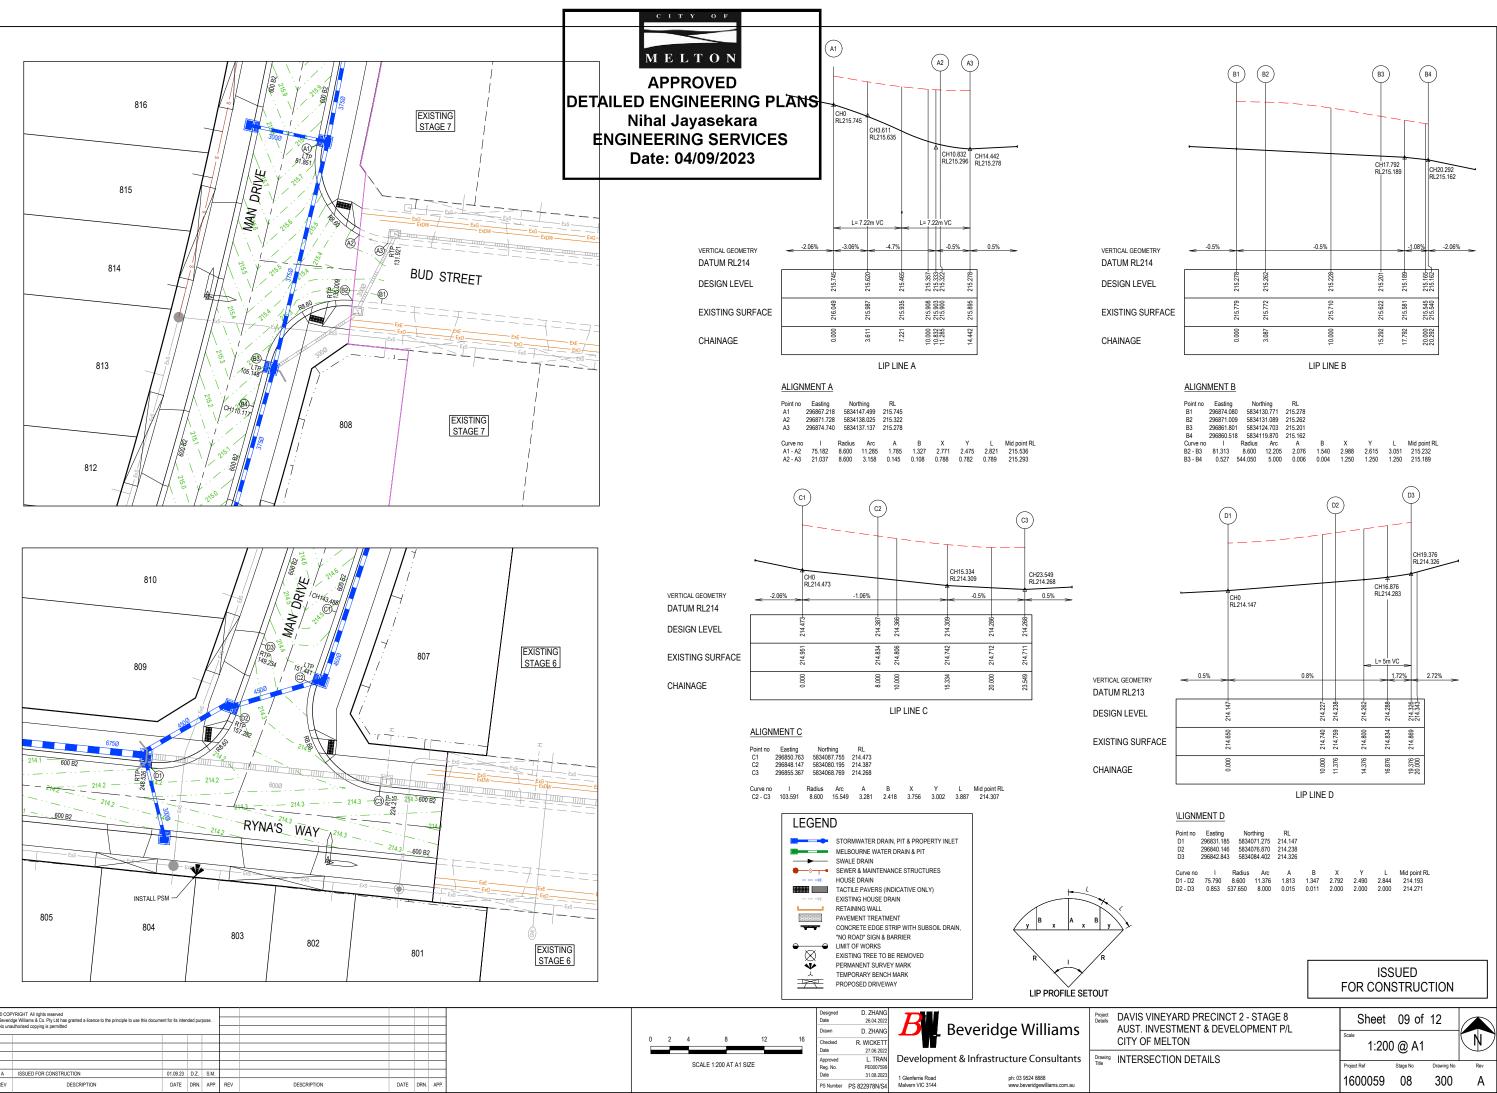
LEGEND

\_\_\_\_\_ EXISTING SURFACE DESIGN SURFACE

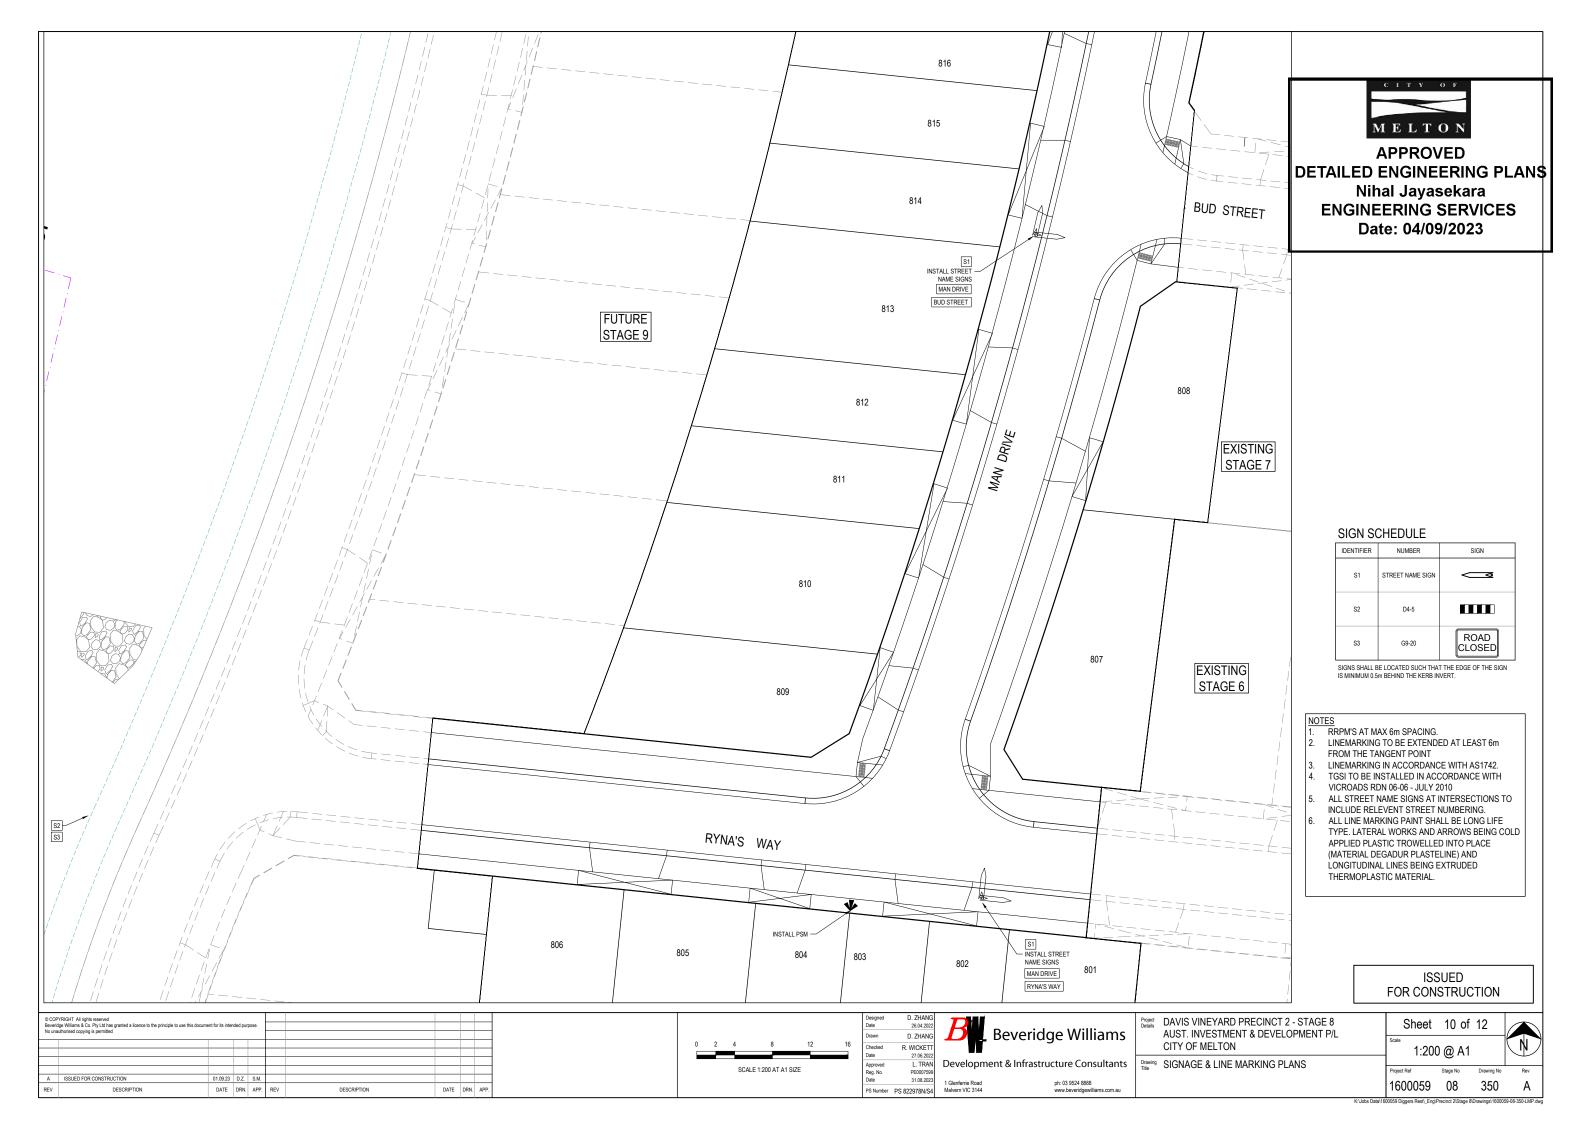
STRUCTURAL FILL

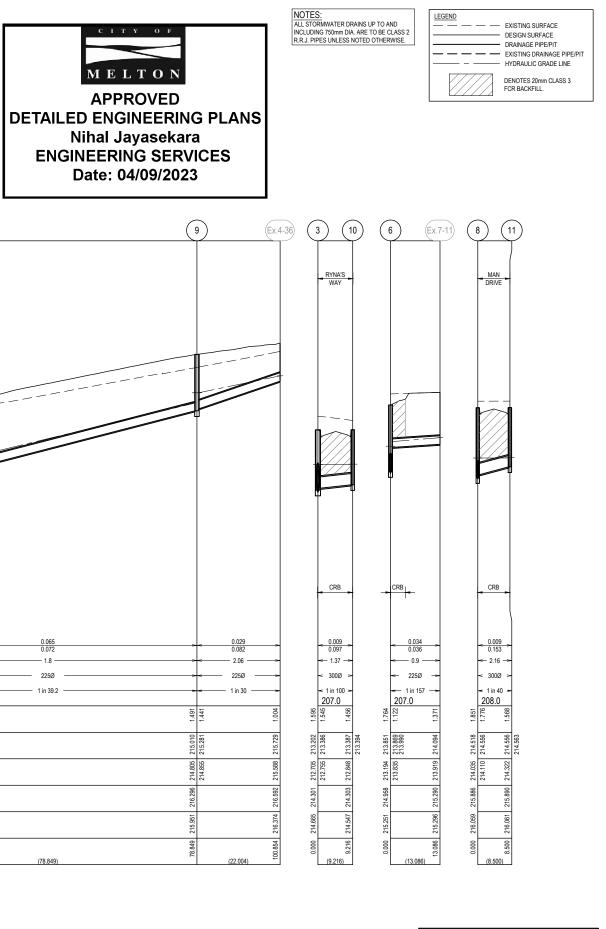
1 in 20	1 in	RBL		
214.473- 214.583-	214.708-	214.738- 214.739	215.406-	
214.951 214.951	214.951	214.951 214.951	214.952	
3.200 3.800	6.300	7.850	1.850	
			106	
1 in 20		RBL		
214.961 - 214.961 -	215.086-	215.116-215.117	215.784 -	
215.277 215.277	215.277	215.277 215.277	215.277	
3.200 3.800	6.300	7.800	11.850	

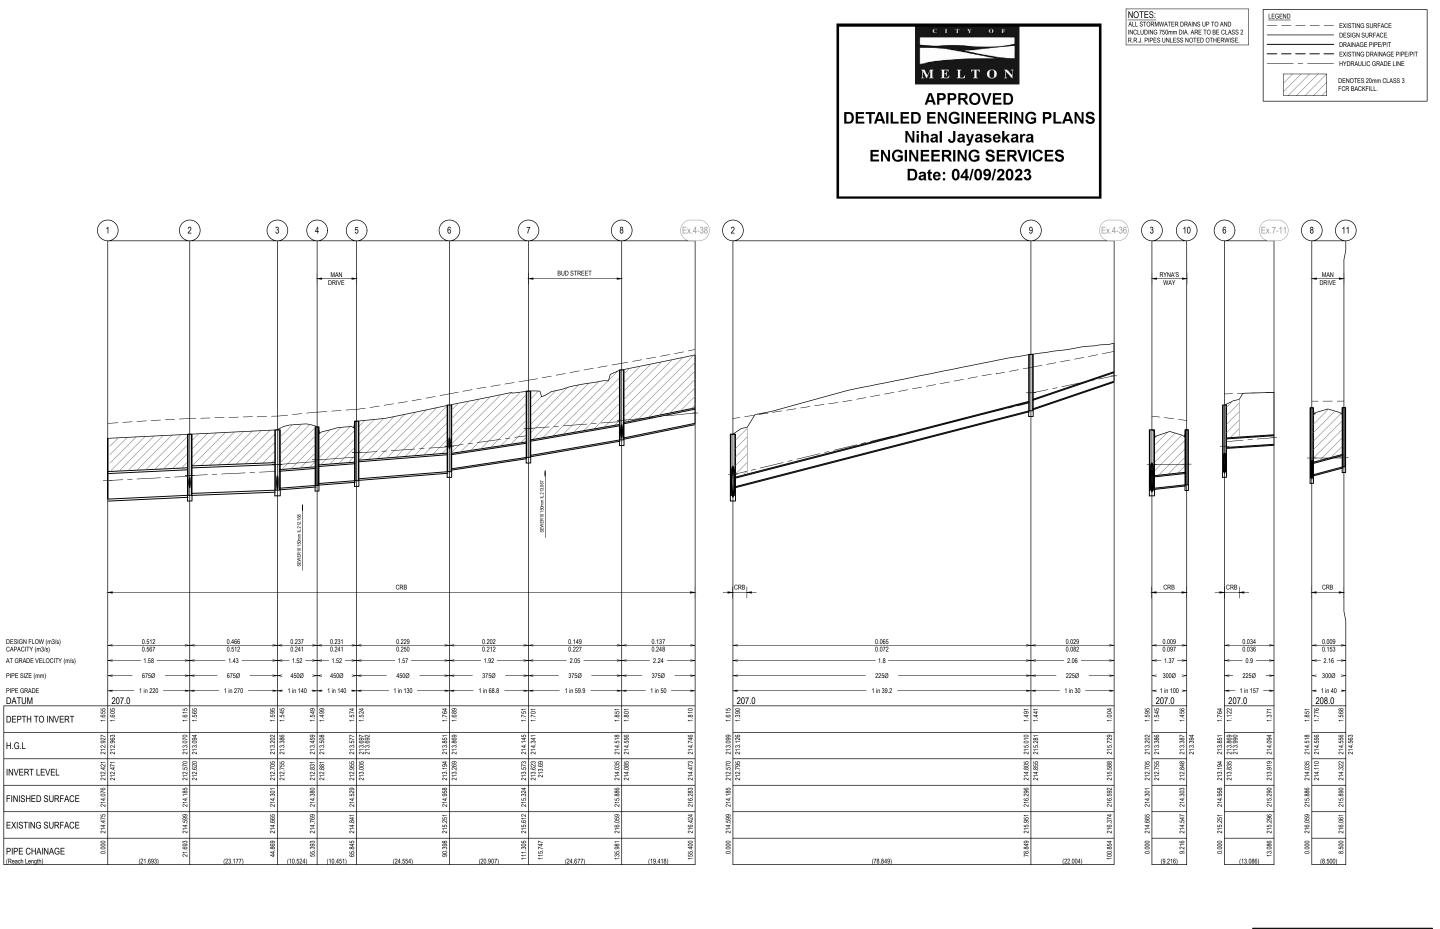
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A      ISSUED FOR CONSTRUCTION      0.10.92.3      D.Z.      S.M.      O      O      O      D        REV      DESCRIPTION      DATE      DRV.      APP.      REV      DESCRIPTION      DATE      ORN.      APP.	VERT 1:50 0 0.5 1 2 3 SCALE AT A1 SIZE A Approved L. TRAN SCALE AT A1 SIZE BAB. New PS 822978N/S4 Malvern VIC 3144 www.beverldgewilliams.com.au Pt: 03 9524 8888 Malvern VIC 3144 www.beverldgewilliams.com.au Pt: 03 9524 8888	Project Ref      Stage No      Drawing No      Rev        1600059      08      400      A        Kt\Jobs Data1160059 Diggers Rest_Eng/Precinct 258age 8/Drawings1600059:08-400-DLS      Comparison      Comparison

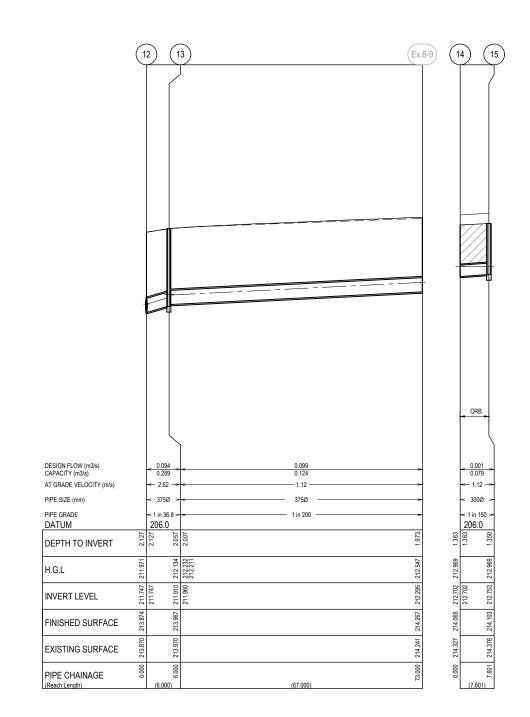
PIPE GRADE

DATUM

H.G.L

(Reach Length)





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			_				_	_		HORIZ 1:500 0 5 10 20	30	Checked	R. WICKETT			
			-	-				-		VERT 1:50 0 0.5 1 2		Date Approved	27.06.2022	Development & Infrastructure Consult	ante	
										SCALE AT A1 SIZE		Reg. No.	PE0007599	Development & innastructure consult	ints	
A		01.09.23 D DATE DI	_	_	REV DESCRIPTION	DAT	E DRM		00			Date	31.08.2023	1 Glenferrie Road ph: 03 9524 8888 Malvern VIC 3144 www.beveridoewilliams.ci		
REV.	DESCRIPTION	DATE	r.iv. 7	NFF.	REV DESCRIPTION	DAT		v. Ar	чгг.			PS Number	PS 822978N/S4	Malvern VIC 3144 www.beveridgewilliams.c	m.au	

EXISTING SURFACE
DESIGN SURFACE
DRAINAGE PIPE/PIT
EXISTING DRAINAGE PIPE/PIT
HYDRAULIC GRADE LINE

	FOR CC	SSL DNS		TION	
INEYARD PRECINCT 2 - STAGE 8 IVESTMENT & DEVELOPMENT P/L MELTON	Shee Scale 1:500		12 of 50 V (		
GE LONGITUDINAL SECTIONS 2 OF 2) HEDULE	Project Ref 160005	SI	age No 08	Drawing No 401	Rev A
	Jobs Data\1600059 Diggers Rest	Eng\Prec	inct 2\Stage 8	Drawings\160005	9-08-400-DLS.dwg